

GENERAL GRADING NOTES:



- MATCH EXISTING GRADE AT PROPERTY / DEVELOPMENT LIMITS WITH SODDED SLOPES OF MAXIMUM 3:1 AND/OR RETAINING WALLS AS SPECIFIED.
- SLOPES OF SWALES FOR BOTH "BACK-TO-FRONT" AND "SPLIT" DRAINAGE SHALL BE NO LESS THAN 2.0% AND NO GREATER THAN 33% (3:1).
- MINIMUM GRADE FOR ATRON "WRAP-AROUND" SWALE AT THE REAR OF THE UNIT SHALL BE 1%.
- SWALES SHALL NOT EXCEED 1.5% GRADE. IF THE SWALE IS 1.5% OR LESS, A 2.0% SLOPE CANNOT BE REASONABLY ACHIEVED A 1.5% GRADE IS PERMITTED PROVIDED A 150MM SUB-DRAIN IS INSTALLED.
- DRIVEWAY SLOPES SHALL NOT BE LESS THAN 2.0% AND SHALL NOT BE MORE THAN 7%. REVERSED SLOPED DRIVEWAYS ARE NOT ALLOWED FOR ANY NEW CONSTRUCTION.
- GARAGE FLOOR ELEVATION SHALL BE SET A MINIMUM OF 0.30M HIGHER THAN THE BACK OF WALK UNLESS OTHERWISE SPECIFIED.
- THE TOP OF FOUNDATION WALL FOR THE DWELLING UNIT SHALL BE A MINIMUM 100MM (6") ABOVE FINISHED GRADE.
- UNLESS OTHERWISE NOTED, THE GRADE BETWEEN PROPOSED ELEVATIONS SHALL BE GRADED AS A STRAIGHT LINE.
- RETAINING WALLS ARE REQUIRED ON THE PROPERTY / DEVELOPMENT WHICH ARE NOT OWNED BY THE DEVELOPER. THEN THE DEVELOPER MUST OBTAIN WRITTEN PERMISSION FROM THE ADJACENT PROPERTY OWNER OTHER THAN RETAINING WALLS MUST BE USED.
- ALL RETAINING WALLS SHALL BE PLACED A MINIMUM 0.45M FROM PROPERTY LINES.
- ANY WALL OF GREATER HEIGHT THAN 1.0M MUST BE DESIGNED BY A PROFESSIONAL ENGINEER.
- TOP OF RETAINING WALL ELEVATIONS SHALL BE SET A MINIMUM OF 150MM ABOVE THE PROPOSED SIDE-YARD SWALES.
- RETAINING WALLS 0.60M AND HIGHER REQUIRE CONSTRUCTION OF A FENCE OR GUARD RAIL AT THE TOP OF THE REAR OF THE WALL. SUCH FENCES OR GUARD RAILS SHALL BE DESIGNED AND CONSTRUCTED IN ACCORDANCE WITH THE REQUIREMENTS OF THE ONTARIO BUILDING CODE.
- ALL FILL COMPACTED ON THE LOTS SHALL BE COMPACTED TO A MINIMUM 95% SPD (UNLESS OTHERWISE RECOMMENDED BY A GEOTECHNICAL ENGINEER). MATERIALS SHALL BE PLACED IN LIFTS NOT EXCEEDING 300MM DEPTH.
- FOR DELINEATION OF TREE PROTECTION ZONES, BUFFERS, REMOVALS, AND PROTECTION SCHEMATICS REFER TO THE TREE PROTECTION PLAN (IF APPLICABLE).

BACKYARD GRADING NOTES:

- "REQUIRED BACKYARD" SHALL BE A MINIMUM OF 6.0 METRES UNLESS OTHERWISE DEFINED IN THE APPLICABLE ZONING BY-LAW.
- GRADE BETWEEN PROPOSED ELEVATIONS SHALL BE 5% EXCEPT FOR SIDE OR REAR YARD SWALES AND RETAINING WALLS.
- WHERE THE 5% RESTRICTION ON THE BACKYARD'S GRADES RESULTS IN ELEVATION DIFFERENCES BETWEEN ADJACENT PROPERTIES, RETAINING WALL SHALL BE CONSTRUCTED ALONG THE SIDES AND BACK OF THE LOT.
- GENERALLY, SLOPES SHALL BE PLACED ON THE LOWER LOT, WHEREAS RETAINING WALLS SHALL BE PLACED ON THE HIGHER LANDS.
- THE 5% RESTRICTION DOES NOT PRECLUDE RETAINING WALLS IN THE REQUIRED BACKYARDS PROVIDED THE TERRACES ARE MAINTAINED TO THE 5% GRADE AS SET OUT ABOVE. THE INTENTION OF THIS PROVISION IS TO PROVIDE FOR FLEXIBILITY OF HOUSE CONSTRUCTION.
- BACK TO FRONT DRAINAGE SHALL ONLY BE PERMITTED WHERE THE COMBINED SIDE YARD SETBACK IS 2.0M OR MORE, PROVIDING A MINIMUM OF 2.0M BETWEEN FOUNDATION WALLS FOR DRAINAGE SWALES. A 1.2M SETBACK IS REQUIRED ON THE GARAGE SIDE OF THE LOT.

SILTATION CONTROL NOTES:

- SILTATION CONTROL BARRIERS SHALL BE PLACED AS DETAILED ON THE PLAN ACCORDING TO OPSD 219.110 (SEE DETAIL ON THIS SHEET).
- ALL SILTATION CONTROL MEASURES SHALL BE CLEANED AND MAINTAINED AFTER EACH RAINFALL EVENT TO THE SATISFACTION OF THE CITY OF HAMILTON.
- CATCH BASIN SEDIMENT CONTROL DEVICES SHALL BE SILTACK BY ACM ENVIRONMENTAL OR APPROVED EQUIVALENT, TO BE PLACED AS PER THE MANUFACTURER'S RECOMMENDATIONS (IF APPLICABLE).
- ADDITIONAL SILTATION CONTROL MEASURES MAY BE REQUIRED AS PER FIELD CONDITIONS AS DETERMINED BY THE CITY.

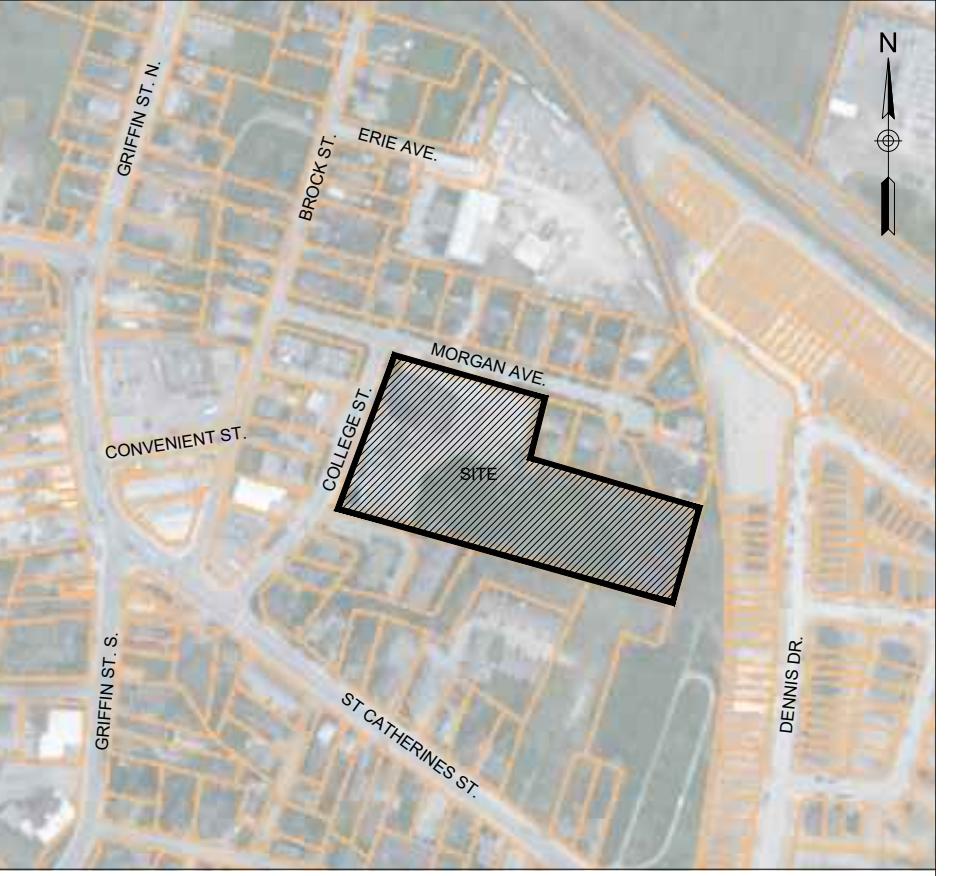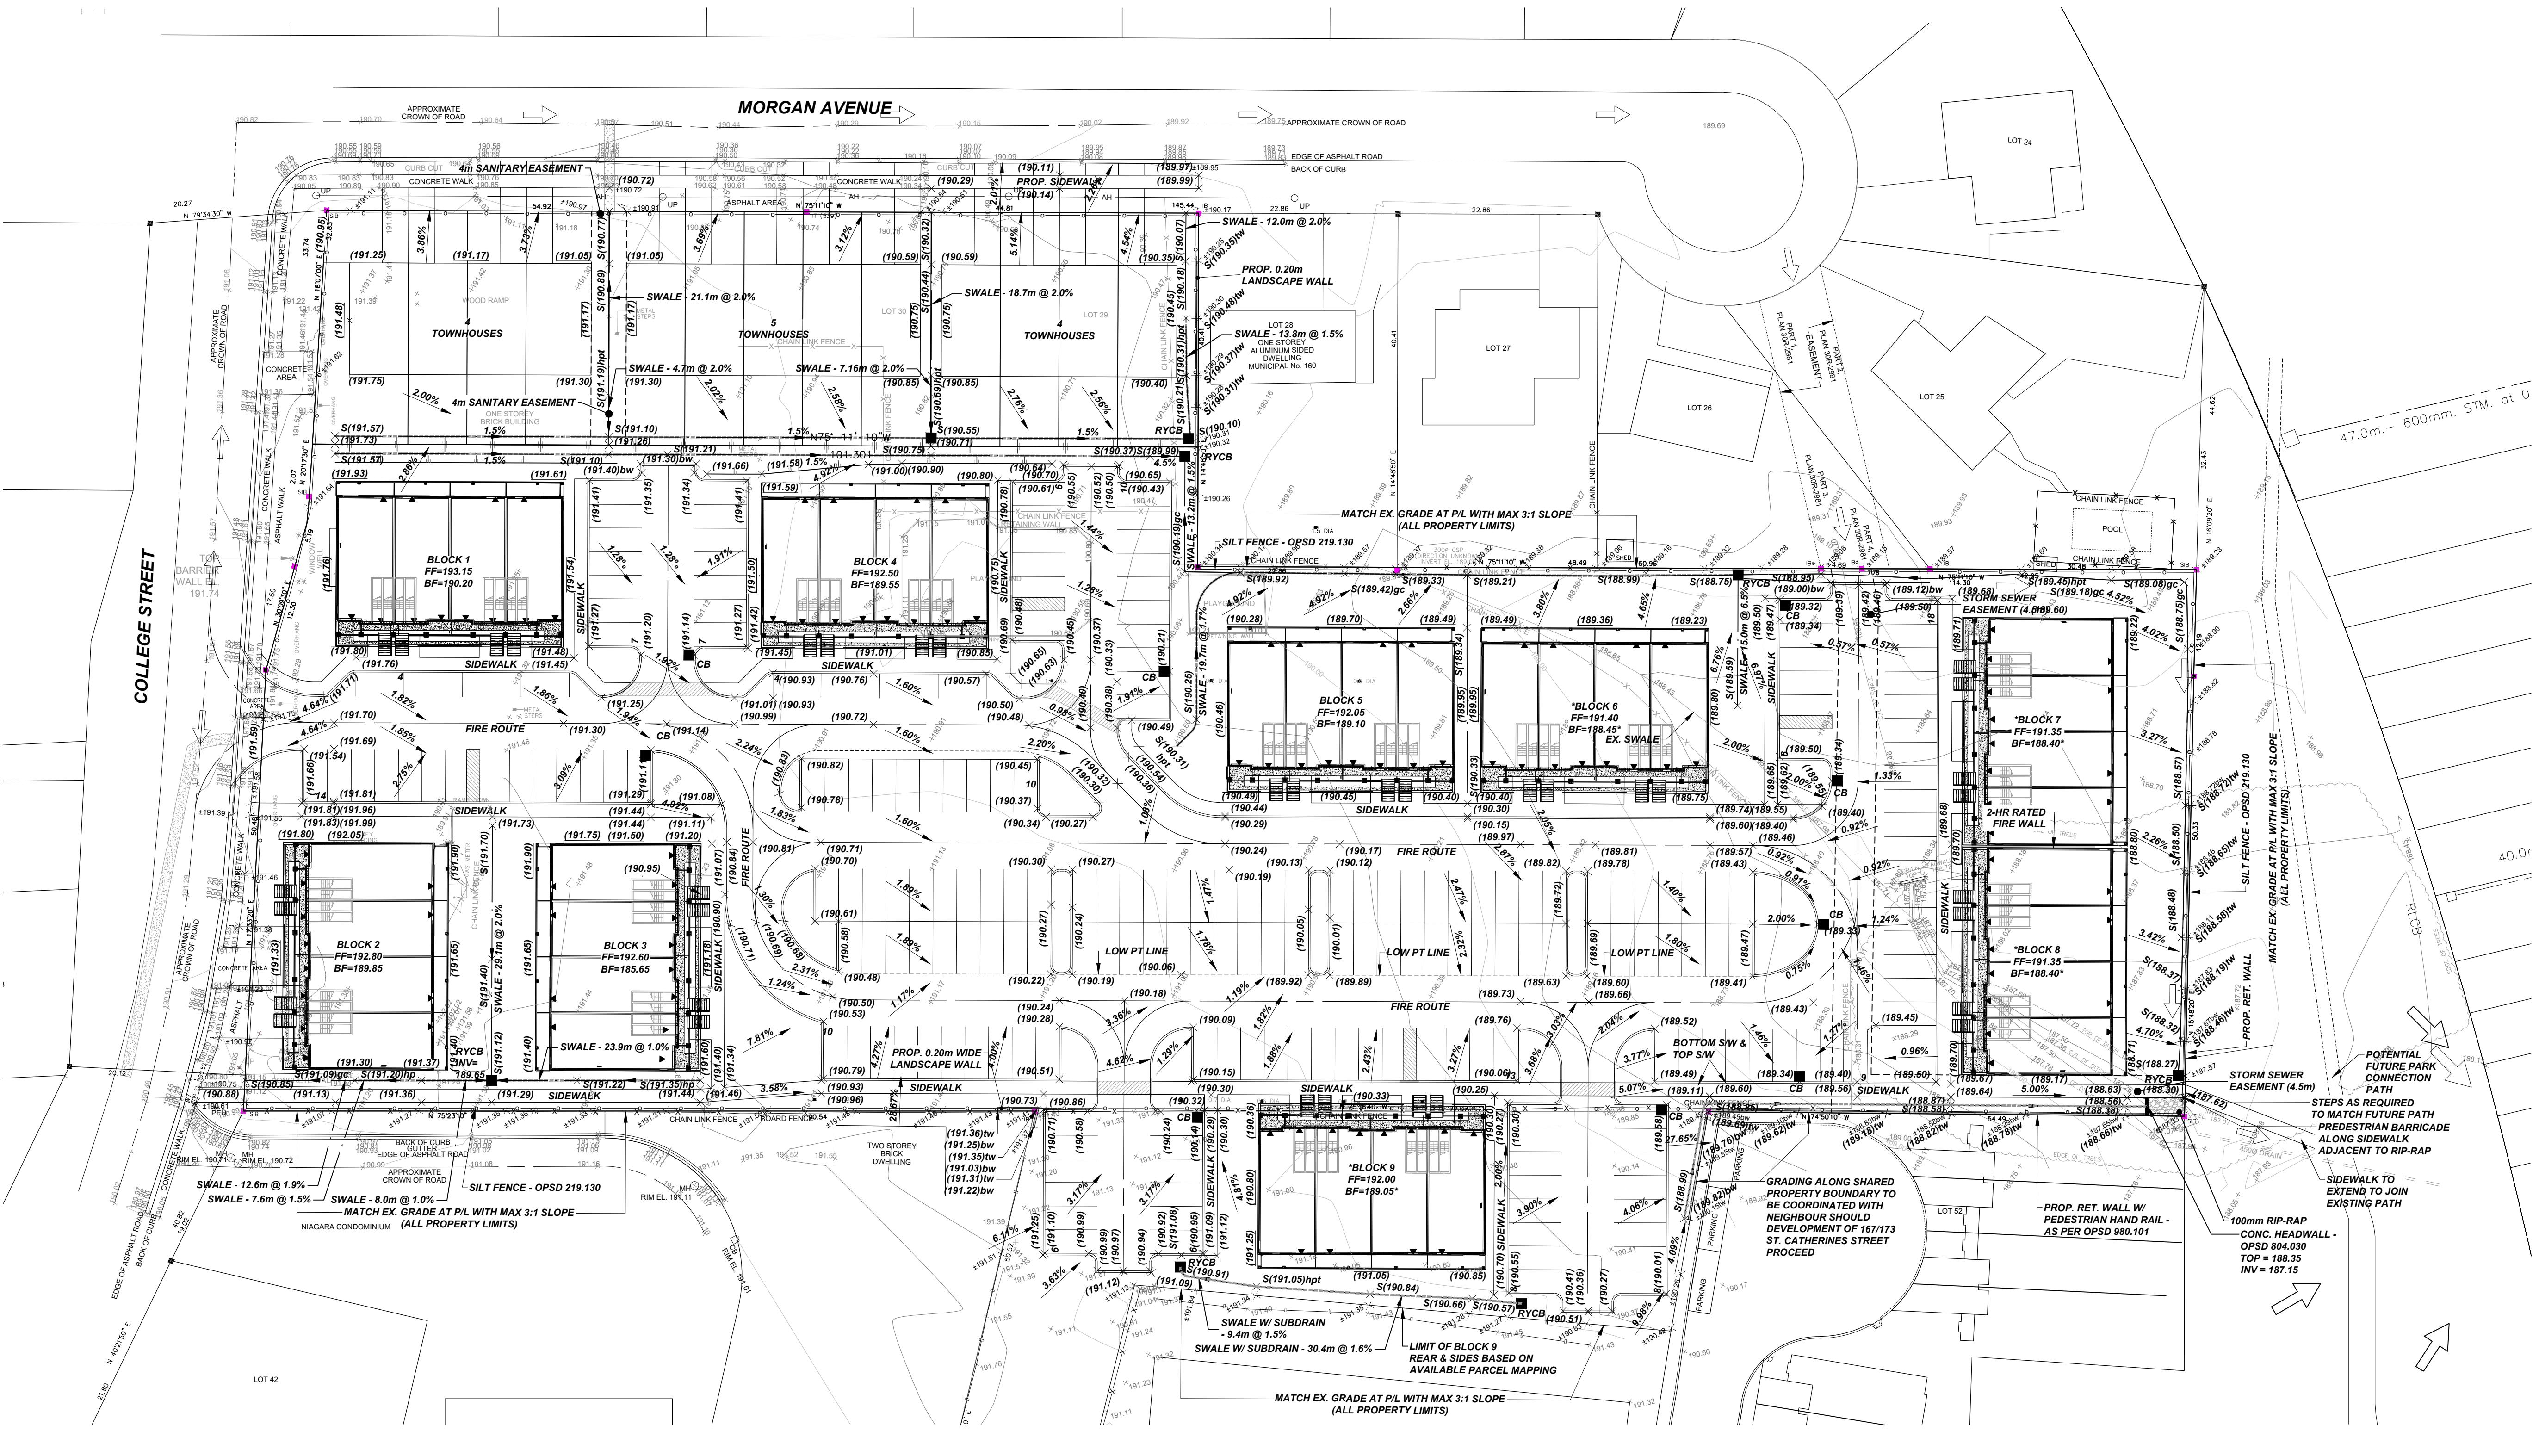

KEY PLAN N.T.S.


BENCHMARK NOTE:
ELEVATION =
MONUMENT:

SITE BENCHMARK:
ELEVATION =

GENERAL NOTES:

- TENDERERS SHALL SATISFY THEMSELVES AS TO THE NATURE OF THE GROUND AND BED, ACCORDINGLY.
- ALL ROCK LINE INDICATIONS SHOWN ON THE PLAN MUST BE VERIFIED BY THE CONTRACTOR.
- CONTRACTOR SHALL VERIFY LOCATIONS AND INVERTS OF ALL EXISTING SANITARY AND STORM SEWERS AND WATERMAINS, PRIVATE DRAINS AND WATER SERVICES, GAS MAINS, CABLE TV, HYDRO AND TELEPHONE DUCTS ETC AT START OF CONSTRUCTION.

2 2025-06-11 REVISED PER CITY COMMENTS
1 2024-09-26 SWM SUBMISSION
0 2024-08-12 FOR CLIENT REVIEW
NO: DATE: DESCRIPTION: REVISIONS

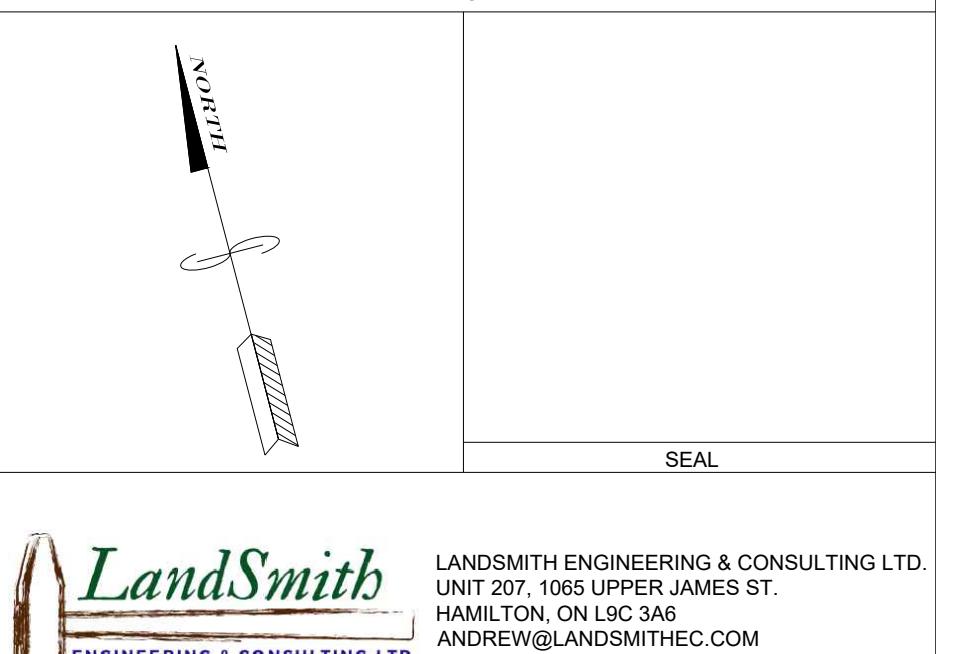

CLIENT:
2853972 ONTARIO INC.

MUNICIPALITY:
TOWNSHIP OF WEST LINCOLN

PROJECT NAME:
COLLEGE STREET SCHOOL

TITLE:
SITE GRADING PLAN

SCALE: 1:400 DATE: 2022-09-27
CHECKED BY: AS DESIGNED BY: AS

DWG No: 22046PHE SHEET No: 1